810 O/A MODULAR GUARD BOOTH

 $(8' \times 10' \text{ ACTUAL SIZE})$

OHIO DESIGN CODES

2007 OHIO BUILDING CODE 2007 OHIO MECHANICAL CODE 2007 OHIO PLUMBING CODE 2005 NATIONAL ELECTRICAL CODE

DESIGN LIVE LOADS

DRAWING INDEX

DRAWING NUMBER	DESCRIPTION
# 1	SPECIFICATIONS
#2	ELEVATIONS
#3	FLOOR / ELECTRICAL PLAN & PLUMBING SCHEMATICS
#4	CROSS SECTION / BLOCKING POINTS PLAN

ADEQUATE HANDICAPPED REST ROOM FACILITIES TO HANDLE THE ADDITIONAL OCCUPANT LOAD CREATED BY THE ADDITION OF THIS BUILDING TO A SITE SHALL BE PROVIDED IN AN ADJACENT BUILDING ON THE SAME PROPERTY. THE LOCAL OFFICIAL HAVING JURISDICTION SHALL VERIFY THE EXISTING FACILITIES.

ACCESSIBILITY EXCEPTIONS:

PER SECTION 1103.2.7 RAISED AREAS. RAISED AREAS USED PRIMARILY FOR PURPOSES OF SECURITY, LIFE SAFETY OR FIRE SAFETY INCLUDING, BUT NOT LIMITED TO, OBSERVATION GALLERIES, PRISON GUARD TOWERS, FIRE TOWERS OR LIFEGUARD STANDS ARE NOT REQUIRED TO BE ACCESSIBLE OR TO BE SERVED BY AN ACCESSIBLE ROUTE.

PER SECTION 1103.2.10 SINGLE-OCCUPANT STRUCTURES. SINGLE-OCCUPANT STRUCTURES ACCESSED ONLY BY PASSAGEWAYS BELOW GRADE OR ELEVATED ABOVE GRADE INCLUDING, BUT NOT LIMITED TO, TOLL BOOTHS THAT ARE ACCESSED ONLY BY UNDERGROUND TUNNELS, ARE NOT REQUIRED TO BE ACCESSIBLE.

3/17/09 JUB NU: 200	DRAWING NO:
I WIN MODULAR SERVICES, INC.	1001 LOWER LANDING RD, SUITE 607, BLACKWOOD, NJ 08
R.M.	REV.
1EET	GUARD BOOTH


CHASSIS **ELECTRICAL** TYPE: PERIMETER MAIN DISTRIBUTION PANEL: EXTERIOR (WEATHERPROOF) 100 AMP 120/240 VOLT SINGLE PHASE, 3 WIRE, 60 HZ. WITH GROUND MAIN BEAM: 6" JR. I-BEAM (4.4 lbs PER FT.) RACEWAY: MINIMUM #14/2 W/ GROUND 90 DEG. C. TYPE MC, COPPER CROSS MEMBERS: 6" JR. 1-BEAM @ 24" O.C. INTERIOR LIGHTS: 2'x4' TWO TUBE LAY-IN FLUORESCENT TROFFER PER PRINT PAINT: ASPHALT BASED 2'x2' TWO TUBE LAY-IN FLUORESCENT TROFFER PER PRINT STANDARD: 6" "C" CHANNEL 8.5 lbs PER FT. EXTERIOR LIGHTS: 150 WATT QUARTZ HALOGEN SECURITY LIGHT (WEATHERPROOF) SWITCHES: 120 V. 15 AMP SINGLE POLE PER PRINT **FLOOR** RECEPTACLES: 120 V. 15 AMP DUPLEX RECEPTS PER PRINT INSULATION: NONE R-19 RIGID INSULATION 120 V. 15 AMP GFI DUPLEX RECEPTS PER PRINT DECKING: 3/4" PLYWOOD, 24 O.C. SECURED DIRECTLY TO STEEL FRAME 120 V. 15 AMP GFI, WEATHER PROOF, DUPLEX RECEPTS PER PRINT OPTIONAL: 1/4" STEEL PLATE FLOOR W/ NON-SKIP EPOXY PAINT EXHAUST FAN: 75 CFM EXHAUST FAN COVERING: 1/8"x12"x12" WNYL TILE RESTROOM- 1/8"Aluminum Tread **PLUMBING** TRIM: 4" VINYL COVE BASE Plate in Guard Area SUPPLY: TYPE "L" COPPER, CONCEALED W/ SHUTOFF'S @ EACH FIXTURE MOISTURE BARRIER: TYVEK OR EQUAL DWV: SCHEDULE 40 PVC CONCEALED S S EXTERIOR WALLS WATER CLOSET: STANDARD TANK TYPE W/ ELONGATED BOWL AND OPEN FRONT SEAT LAVATORY: STANDARD WALL HUNG STUDS: 2"x4" STUD GRADE SPF @ 16" O.C. SERVICES, WATER HEATER: EEMAX OR CHRONOMITE INSTANTANEOUS, ELECTRIC BOTTOM PLATE: SINGLE 2"x4" #3 SPF TOP PLATE SINGLE 2"x4" #3 SPF H.V.A.C. WALL HEIGHT: 8'-3" HEATING: 240V 3000 Watt Wall Heater With Fan FINISHED CEILING HT: 7'-8" A.F.F. AIR CONDITIONING: 110V, DEDICATED CIRCUIT, 8000 BTU WALL MOUNT, INSULATION: R-13 FIBERGLASS KRAFT-BACKED BATTS STANDARD OPTION: 11.600 HEAT / AIR CONDITIONER COMBINATION UNIT, WALL MOUNTED MODULAR INT. WALL COVERING: 1/4" VINYL COVERED PANEL (CLASS III) INT. WALL COVERING OPTION: 1/2" VINYL COVERED GYP. (CLASS I) EXTERIOR WINDOWS & DOORS -DOORS: 36"x80" ALUM. DOOR, ALUM. FRAME, FOAM INSULATED W/ 14"x14" S.G., LEVER PASSAGE HARDWARE INTERIOR WALLS STANDARD 36"x80" STEEL DOOR W/ 22"x30" WINDOW (S.G.), CLOSER WHITE WITH NON CORROSIVE VINYL TRIM STUDS: 2"x4" STUD GRADE SPF @ 16" O.C. NIX L BOTTOM PLATE: SINGLE 2"x4" #3 SPF WINDOWS: (5) 36"x39" HORIZONTAL SLIDER, ALUM. MILL FRAME, SINGLE GLAZE TOP PLATE SINGLE 2"x4" #3 SPF (1) 36"X39" CLEAR TEMPERED GLASS - HORIZONTAL SLIDER, ALUM. MILL FRAME FINISHED CEILING HT: 7'-8" A.F.F. STANDARD (5)36"x39" HORIZONTAL SLIDER, VINYL THERMAL INSULATED WINDOWS WITH NON CORROSIVE VINYL TRIM - WHITE INT. WALL COVERING: 1/4" VINYL COVERED PANEL (CLASS III) OPTION: (1) 24"x36" CLEAR TEMPERED GLASS TICKET WINDOW WITH STAINLESS STEEL SHELF, SPEAK-THRU & 1/2 ROUND TICKET SERVICE DOORS: 24"x80" HOLLOW CORE WOOD DOOR, STD. LEVER PRIVACY HARDWARE OPTION: 36"x39" PICTURE WINDOW - NON OPERABLE. THERMAL PANE DIG GLAZING W/ VINYL FRAME OR SINGLE GLAZING, MILL FINISH FRAME **EXTERIOR FINISHES** ROOF SIDING: .019 ALUMINUM LITE GRAY TYPE: RAFTER 2X8 BOW TYPE WITH VENTILATION TRIM: .019 ALUMINUM DARK GRAY STANDARD: 3" OVERHANG ALL SIDES WALL SHEATHING: 7/16" OSB OR CDX PLYWOOD, 16/0 SPAN INDEX RATING CEILING: 2'x4' T-GRID DROP CEILING @ 7'-8" A.F.F. ROOF SHEATHING: 1/2" CDX PLYWOOD, 16/0 SPAN RATING INSULATION: R-30 UNFACED) FIBERGLASS BATTS ROOF: .45 EPDM RUBBER ROOFING OPTION: 6" OVERHANC **FURNITURE** 2'-0" x 7'-4" COUNTER TOP - WHITE MICA


607, BLACKWOOD,


SUITE

LOWER LANDING

810 O/A GUARD

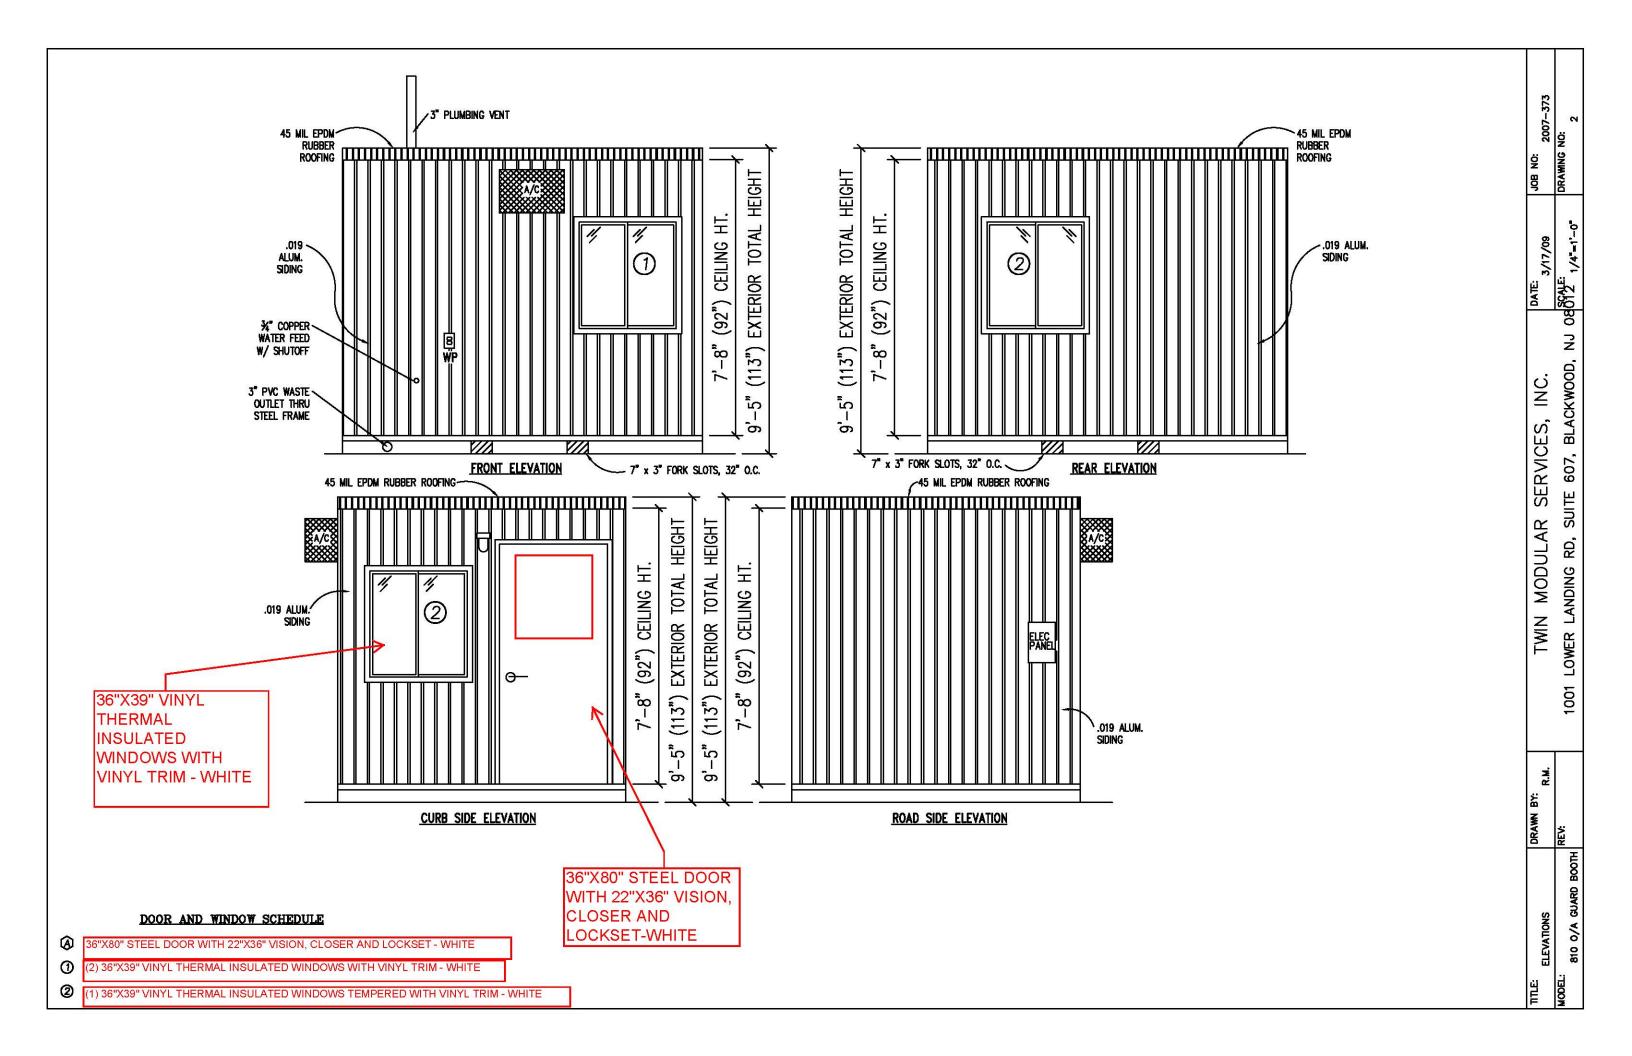

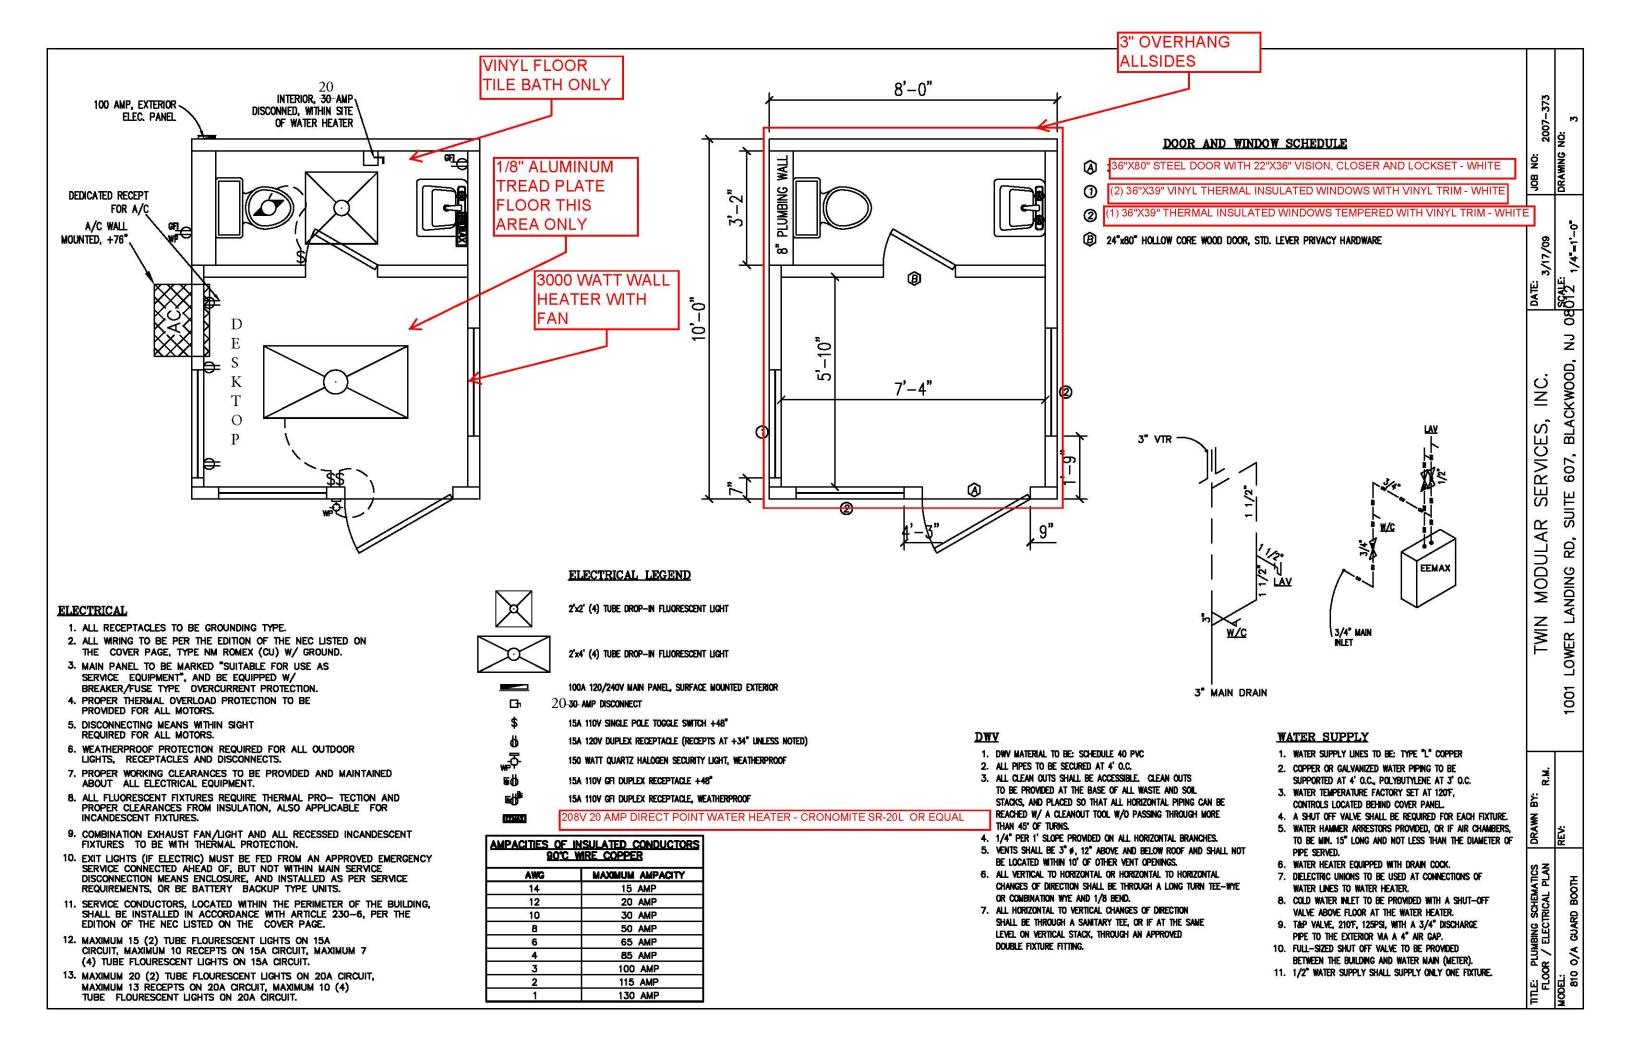

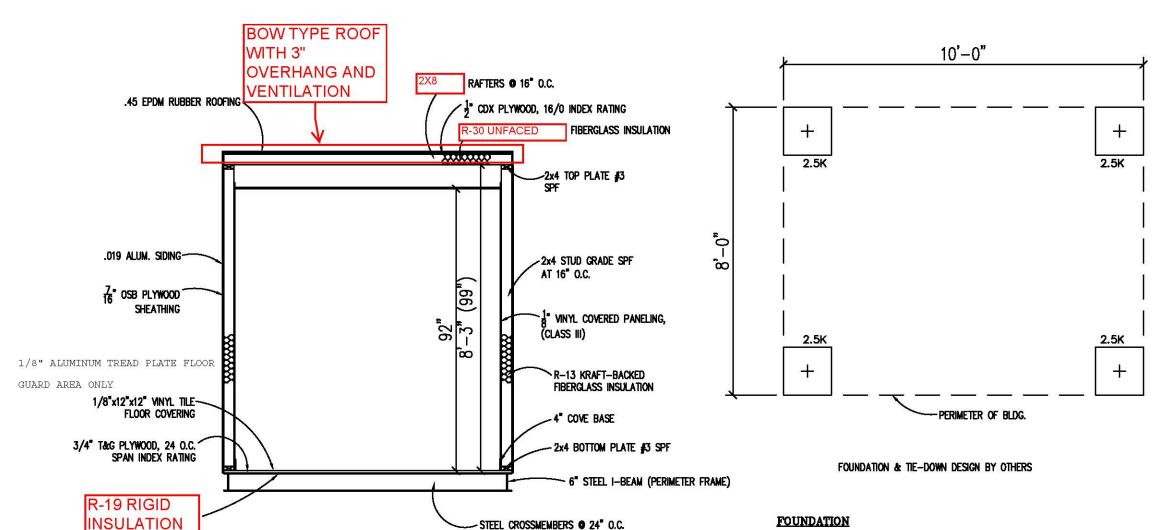

-STEEL CROSSMEMBERS • 24" O.C.

BUILDING CODE

- 1. ATTIC VENTILATION SHALL NOT BE LESS THAN 1/150th OF THE HORIZONTAL AREA TO BE VENTILATED.
- THE BUILDING EXTERIOR AND ALL FACILITIES WITHIN THE BUILDING SHALL BE IDENTIFIED WITH THE INTERNATIONAL SYMBOL OF ACCESSIBILITY.
- 3. OWNER/BUYER SHALL BE RESPONSIBLE FOR ON SITE BARRIER FREE PROVISIONS: STEPS, RAMPS, PARKING SIGNS, ETC. — BUILDING APPROACH (WALK OR RAMP) WITH A MINIMUM WIDTH OF 5' AND A GRADIENT OF NOT MORE THAN 1 FOOT IN 20 FEET.
- ALL LOCKS TO BE UNLOCKABLE FROM THE INTERIOR WITHOUT THE USE OF A KEY OR SPECIAL KNOWLEDGE.
- CORROSION RESISTANT FLASHING AT TOP AND SIDES OF DOORS, WINDOWS AND AT ROOF PENETRATIONS.
- ALL GLAZING WITHIN 24" OF EXTERIOR PASSAGE DOORS AND IN PASSAGE DOORS, OR WITHIN 18" OF FLOOR TO BE "SAFETY GLAZED" AND SO MARKED.

FOUNDATION

- 1. THE PIER LOCATIONS SHOWN ON THIS PLAN ARE FOR THE PURPOSE OF IDENTIFYING THE LOCATION OF THE REQUIRED BLOCKING POINTS AND THE LOADS APPLIED AT EACH POINT FOR THIS BUILDING. FOUNDATION REQUIREMENTS ARE NOT KNOWN DUE TO VARYING SOIL CONDITIONS
- 2. FOUNDATION DESIGN IS BY OTHERS. FOUNDATION REVIEW AND APPROVAL IS TO BE PERFORMED BY THE LOCAL OFFICIAL HAVING JURISDICTION.
- 3. CRAWL SPACE TO BE VENTILATED AT 1 SQ. FT. PER EACH 150 SQ. FT. OF CRAWL SPACE AREA TO BE VENTILATED.
- 4. PROVIDE POSITIVE DRAINAGE UNDER UNIT.
- 5. PROVIDE MINIMUM CRAWL SPACE ACCESS OF $22" \times 24"$.
- 6. MINIMUM FOOTING DEPTH OF BELOW FROSTLINE AND PER LOCAL CONDITIONS.
- 7. PIER LOADS ARE SHOWN IN KIPS
- 8. 90 MPH WIND SPEED, EXPOSURE C
- 9. UNIT MAY BE SHIMMED AS NECCESSARY WITH HARDWOOD SHIMS BETWEEN TOP OF PIER AND MODULAR UNIT FRAME
- 10. MINIMUM CONCRETE STRENGTH SHALL BE 3,000 PSI AT 28 DAYS

DESIGN LOADS

FLOOR LIVE LOAD = 50 PSF FLOOR DEAD LOAD = 10 PSF ROOF LIVE LOAD = 40 PSF ROOF DEAD LOAD = 10 PSF EXTERIOR WALL DEAD LOAD = 42 PLF

FOUNDATION LEGEND

INDICATES BLOCKING TO BOTTOM OF MAIN I-BEAM

TITE: CROSS SECTION	DRAWN BY: R.M.	TWIN MODULAR SERVICES, INC. PATE: 31	60/11/0	JOB NO: 2007-
MODEL: 810 O/A GUARD BOOTH	REV:	1001 LOWER LANDING RD, SUITE 607, BLACKWOOD, NJ 08 872 1/	1/4"=1'-0"	DRAMING NO: